GENERAL

- THESE DRAWINGS SHALL BE READ INI 1 CONJUNCTION WITH ALL ARCHITECTURAL & OTHER WORKING DRAWINGS, SPECIFICATIONS & WITH SUCH WRITTEN INSTRUCTIONS AS MAY BE ISSUED DURING THE COURSE OF THE CONTRACT.
- ALL WORKMANSHIP & MATERIALS SHALL BE IN 2. ACCORDANCE WITH THE REQUIREMENTS OF THE CURRENT EDITION OF THE RELEVANT AUSTRALIAN STANDARDS, THE BUILDING CODE OF AUSTRALIA AND ANY OTHER APPLICABLE AUTHORITY REQUIREMENTS.
- ANY CONFLICT BETWEEN THESE NOTES, THE 3 SPECIFICATION, THE DRAWINGS OR ANY OTHER RELEVANT DOCUMENTS SHALL BE REFERRED TO THE ENGINEER FOR DECISION PRIOR TO PROCEEDING WITH THE WORK
- Δ DIMENSIONS SHALL NOT BE OBTAINED BY SCALING THE DRAWINGS. FOR SETTING OUT DIMENSIONS & LEVELS REFER TO ARCHITECTURAL DRAWINGS.
- THE BUILDER SHALL BE RESPONSIBLE FOR THE 5. PROVISION OF ALL SHORING TO MAINTAIN THE STABILITY & INTEGRITY OF EXCAVATIONS & ADJACENT STRUCTURES
- IT IS THE CONTRACTOR'S RESPONSIBILITY TO 6. LOCATE ALL SERVICES PRIOR TO COMMENCEMENT OF NAY EARTHWORKS.
- 7. ALL DIMENSIONS ARE IN MILLIMETERS UNLESS NOTED OTHERWISE.

STORMWATER

- 1. ALL LEVELS ARE TO A.H.D. UNO
- 2. THE STORMWATER SYSTEM IS DESIGNED TO COMPLY WITH COUNCIL'S DESIGN CRITERIA AND TO APPROXIMATELY MAINTAIN EXISTING FLOW PATTERNS
- З. OVERLAND FLOW PATHS ARE PRESERVED.
- EXISTING DRAINAGE AND LEVELS ARE BASED ON SURVEY PROVIDED 4. & SHOULD BE ASSUMED TO BE APPROXIMATE. ALLOW TO CONFIRM ALL RELEVANT DETAILS BEFORE PROCEEDING WITH AFFECTED AREAS.
- 5. STORMWATER DESIGN AND WORKS TO COMPLY WITH COUNCIL'S DCP, DESIGN CRITERIA AND AS3500
- 6. ALL PITS TO BE PRECAST CONCRETE OR F.R..C. UNO.
- DOWNPIPE LOCATIONS SHOULD BE CONFIRMED WITH 7. ARCHITECTURAL PLANS UNO.
- GRADE LOCAL SURFACES INTO PITS TO ENSURE COLLECTION OF 8. WATER & THAT THERE ARE NO AREAS OF PONDING, TYPICAL
- 9. GRATED TRENCHES AND SILT ARRESTOR PITS TO BE INSPECTED AND CLEANED AFTER PERIODS OF HEAVY RAINFALL.
- 10. TREE ROOTS TO BE AVOIDED DURING PLACEMENT OF DRAINAGE SYSTEM.
- 11. ALL PIPES TO BE Ø100 UPVC UNO.
- 12. ALL PIPES TO HAVE 100MIN. COVER IN LANDSCAPED AREAS AND 600 MIN. COVER IN TRAFFICABLE AREAS.
- 13. ALL INLET AND OUTLET PIPES FROM PITS TO BE CONNECTED AT THE HIGHEST POSSIBLE INVERT LEVEL WHILST KEEPING 1% MIN. GRADE UNO.
- 14. FINISHED SURFACES TO BE GRADED AWAY FROM THE DWELLING AND TOWARD THE PITS.
- 15. GRATED TRENCHES TO BE 1% MIN. GRADE THROUGHOUT TO OUTI FT PIPF
- 16. FINISHED CROSSING AND DRIVEWAY LEVELS ARE BASED ON SURFACE LEVELS OF THE EXISTING LAYBACK AND STREET BOUNDARY LEVELS.
- 17. BEFORE COMMENCING CONSTRUCTION OF THE CROSSING AND DRIVEWAY, COUNCIL'S DESIGNED STREET BOUNDARY LEVELS MUST BE OBTAINED AND USED FOR CONSTRUCTION.

SOIL AND WATER MANAGEMENT NOTES

- 1
- 2. MINIMISE DISTURBED AREAS
- З. FOOTPATHS.
- 4. AS POSSIBLE.
- 5 ALL TIMES
- 6.
- 7.

SEDIMENT CONTROL NOTES

- NSW.
- 2. EARLY AS POSSIBLE DURING DEVELOPMENT.
- З.
- Δ INCLUDING THE MAINTENANCE PERIOD.
- 5. RELEVANT WORKS ARE COMPLETED.
- 6







CONSULTANTS:

REV	DATE	DESCRIPTION
1	28/01/22	

COUNCIL:	Canterbury-Bankstown Council				
DRAWN BY:	A.H				
DESIGNED BY:	R.D B. Adasi				
CLIENT:					
DRAWING TITLE:	Stormwater Notes				

SITE AD
LOT: -
ISSUED
PROJEC

ALL EROSION AND SEDIMENT CONTROL MEASURES TO BE INSPECTED AND MAITAINED DAILY BY SITE MANAGER

ALL STOCKPILES TO BE CLEAR FROM DRAINS, GUTTERS AND

DRAINAGE TO BE CONNECTED TO STORMWATER SYSTEM AS SOON

ROADS AND FOOTPATHS TO BE SWEPT DAILY AND KEPT CLEAN AT

INSTALL TEMPORARY SEDIMENT BARRIERS TO ALL INLET PITS LIKELY TO COLLECT SILT LADDEN WATER, TO COUNCILS'S REQUIREMENTS. NOT WITHSTANDING DETAILS SHOWN, IT IS THE SITE MANAGERS SOLE RESPONSIBILITY TO ENSURE THAT ALL SITE ACTIVITIES COMPLY WITH THE REQUIREMENTS OF THE CLEAN WATERS ACT.

1. ALL EROSION AND SEDIMENTATION CONTROL MEASURES, INCLUDING REVEGETATION AND STORAGE OF SOIL AND TOPSOIL, SHALL BE IMPLEMENTED TO THE STANDARDS OF THE SOIL CONSERVATION OF

ALL DRAINAGE WORKS SHALL BE CONSTRUCTED AND STABILISED AS

SEDIMENT TRAPS SHALL BE CONSTRUCTED AROUND ALL INLET PITS. CONSISTING OF 300mm WIDE X 300mm DEEP TRENCH.

ALL SEDIMENT BASINS AND TRAPS SHALL BE CLEANED WHEN THE STRUCTURES ARE A MAXIMUM OF 60 % FULL OF SOIL MATERIALS.

ALL DISTURBED AREAS SHALL BE REVEGITATED AS SOON AS THE


SOIL AND TOPSOIL STOCKPILES SHALL BE LOCATED AWAY FROM DRAINAGE LINES AND AREA WHERE WATER MAY CONCENTRATE.

7. FILTER SHALL BE CONSTRUCTED BY STRETCHING A FILTER FABRIC (PROPEX OR APPROVED EQUIVALENT BETWEEN POST AT 3.0m CENTRES. FABRIC SHALL BE BURIED 150mm ALONG ITS LOWER EDGE.

> DDRESS: 48 Cornelia St, Wiley Park 2195 SEC: -| DP: 20535 FOR: CDC CT: Addition and Alteration SCALE: N.T.S 28/01/22 REV: R1 DATE: SHEET NO. :



SW-00

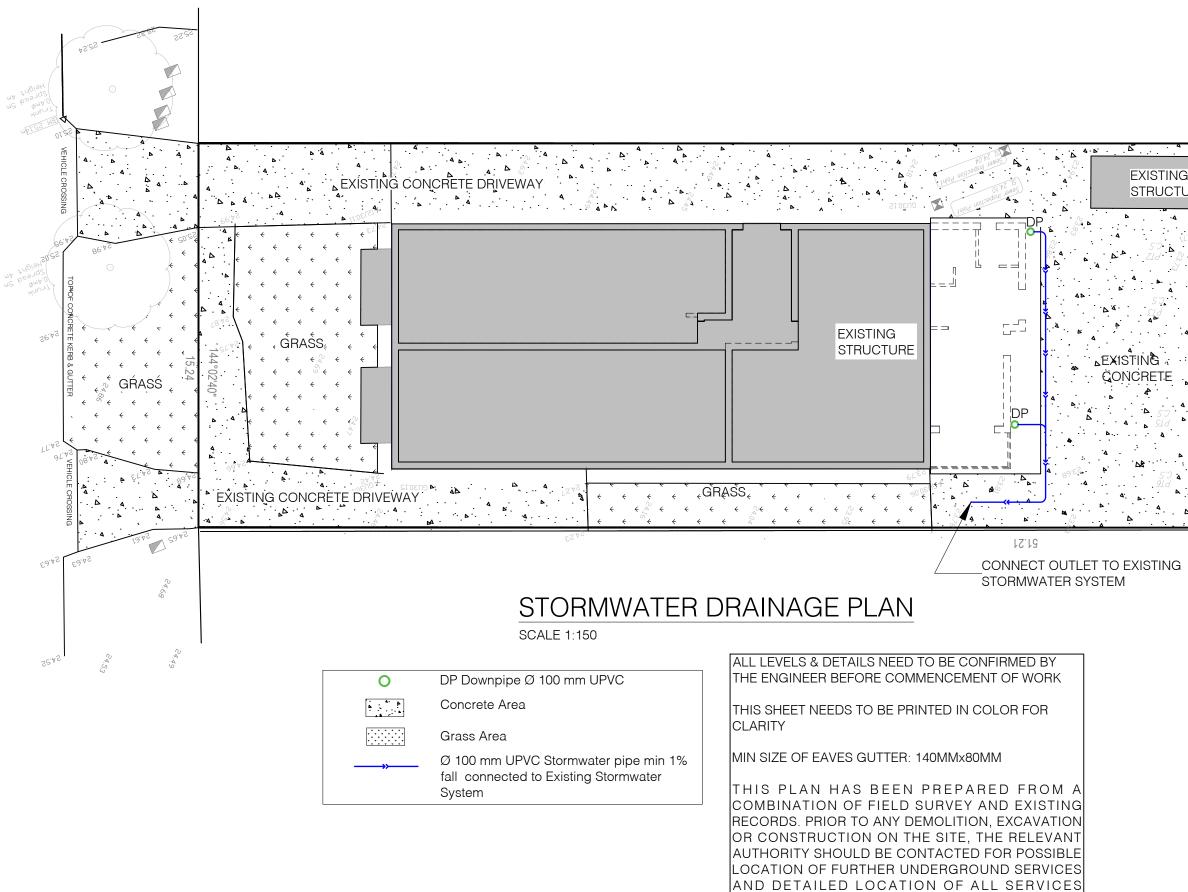

			REV	DATE	DESCRIPTION	COUNCIL:	Canterbury-Bankstown Council	SITE A
TECHNICAL			1	28/01/22		DRAWN BY:	A.H	LOT: -
PROJECTS						DESIGNED BY:	R.D	ISSUED
PROJECTS CONSULTAI	NTS ENGINEERS	-				CLIENT:	B. Adasi	PROJE
	AUSTRALIA MIE(Aus): 5094165	-				DRAWING TITLE:	Stormwater Drainage Plan	SCALE: 1

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ADDRESS: 48 Cornelia St, Wiley Park 2195 | SEC: - | DP: 20535 D FOR: CDC ECT: Addition and Alteration 1:150 @ A3 DATE: 28/01/22 REV: R1 SHEET NO.: SW-01

